


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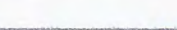



LOCATION PLAN

SCALE: 1:4000

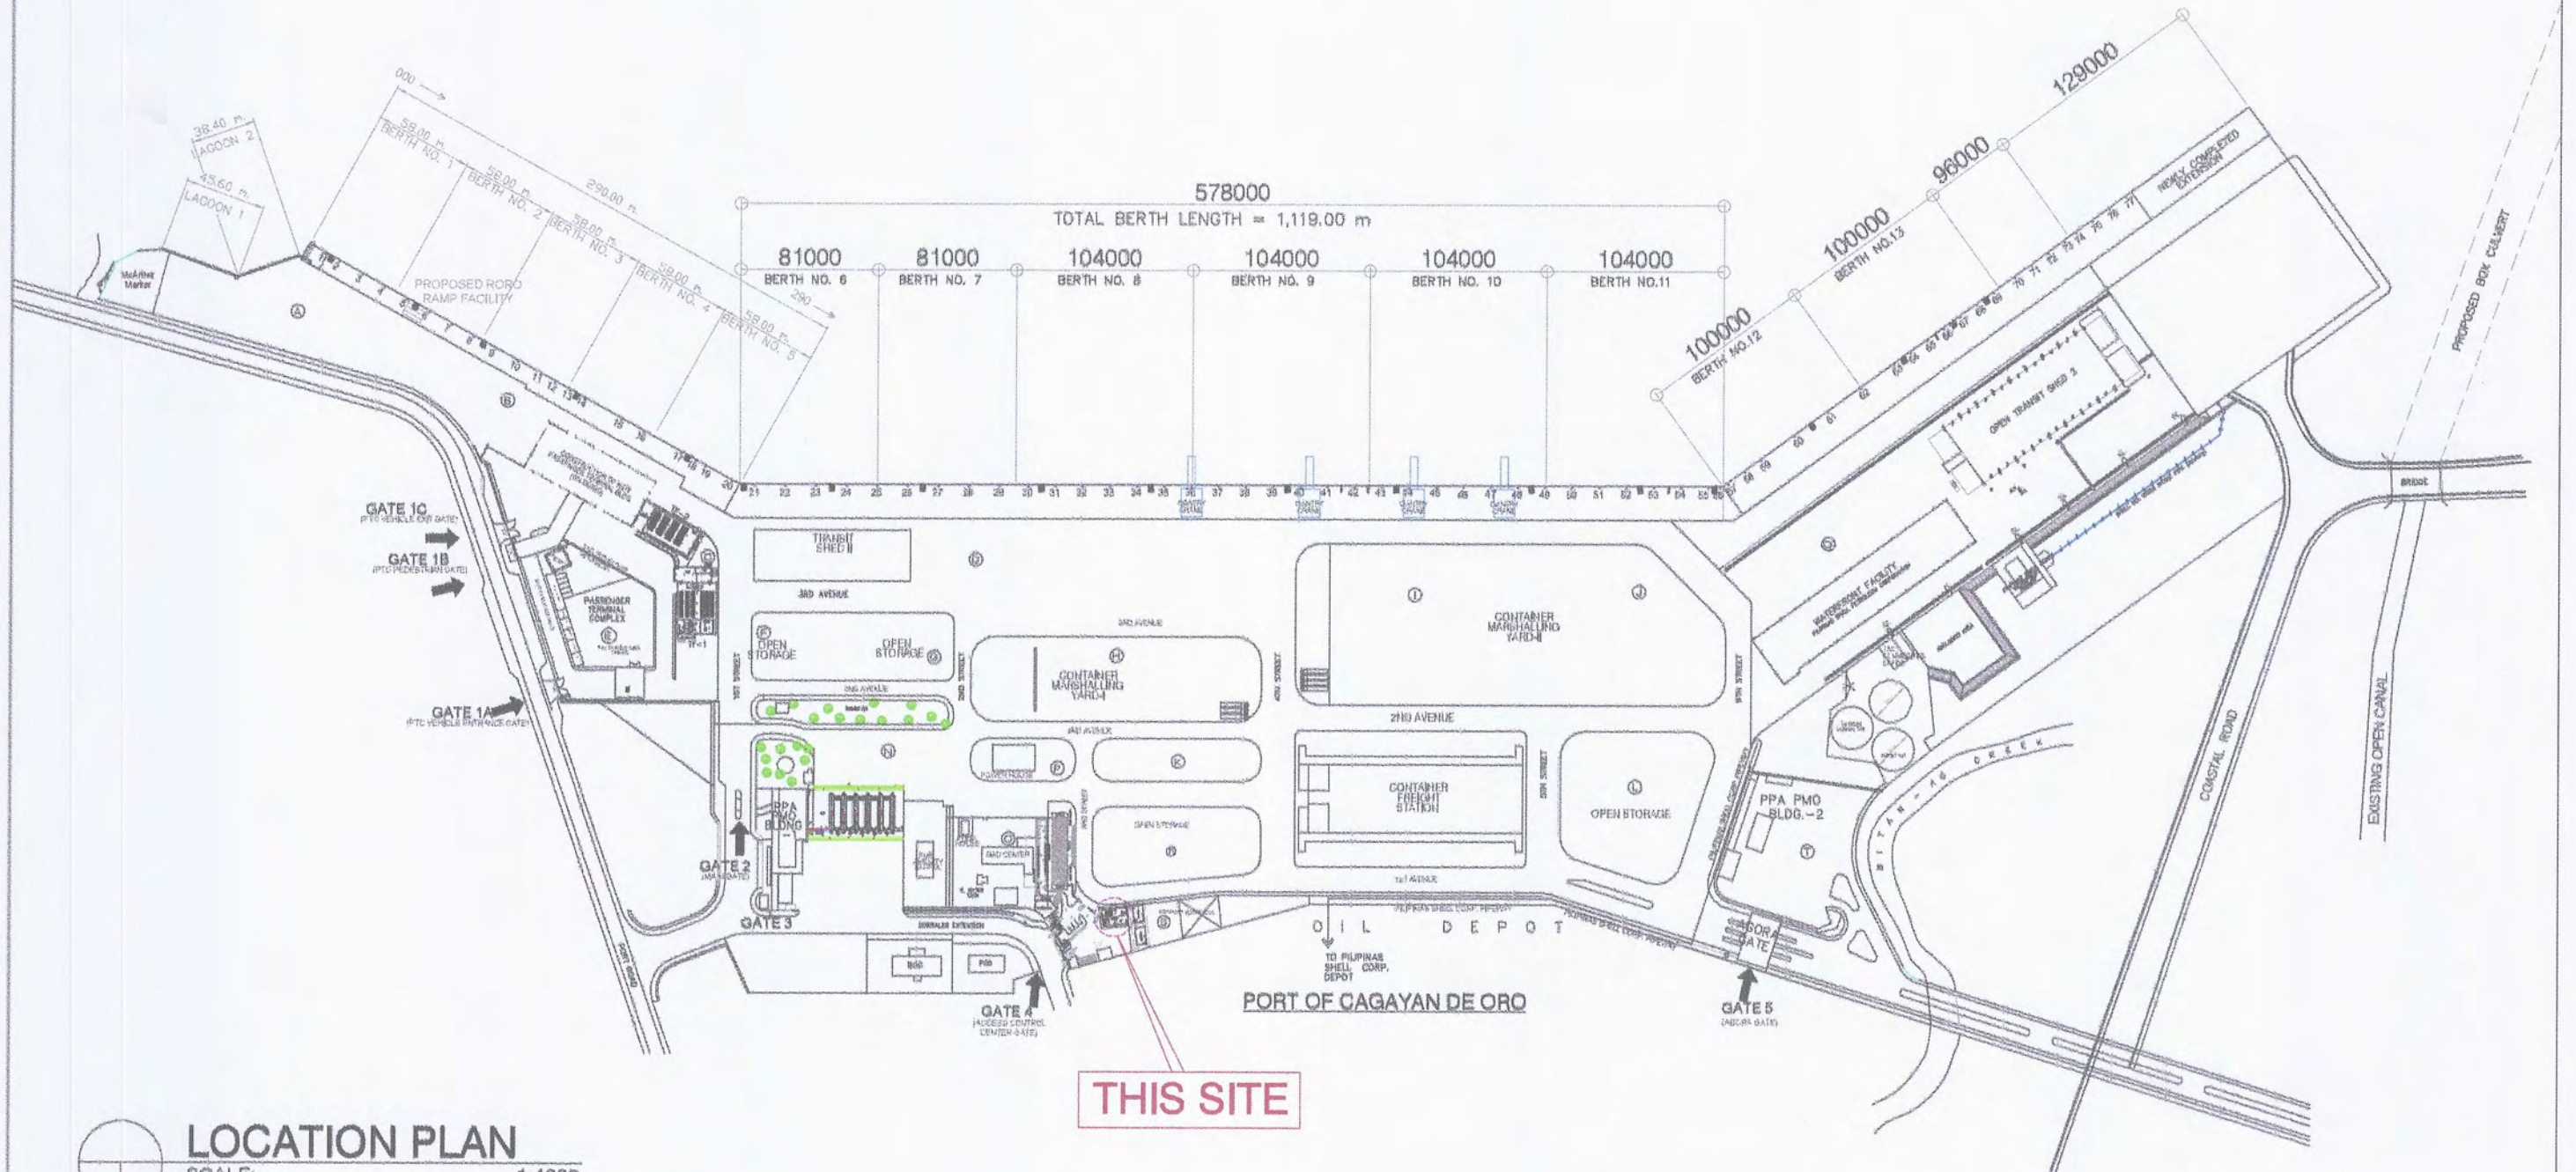

PORT OF
CAGAYAN DE ORO
MISAMIS ORIENTAL

TITLE:		REPAIR OF PORT POLICE OFFICE				SHEET NO.	
LOCATION:		PORT OF CAGAYAN DE ORO				SHEET CONTENTS	
PREPARED BY:		CHECKED BY & SUBMITTED BY:		RECOMMENDED BY:		APPROVED:	
 KAREL T. SUMICAD Construction Foreman		 MARC M. AVELLANA Supervising Engineer A		 ANTONIO M. TORCINO, JR. Acting ESD Manager		 FERNANDO B. MAPALO, JR. Acting Port Manager	
LOCATION PLAN						1 5	

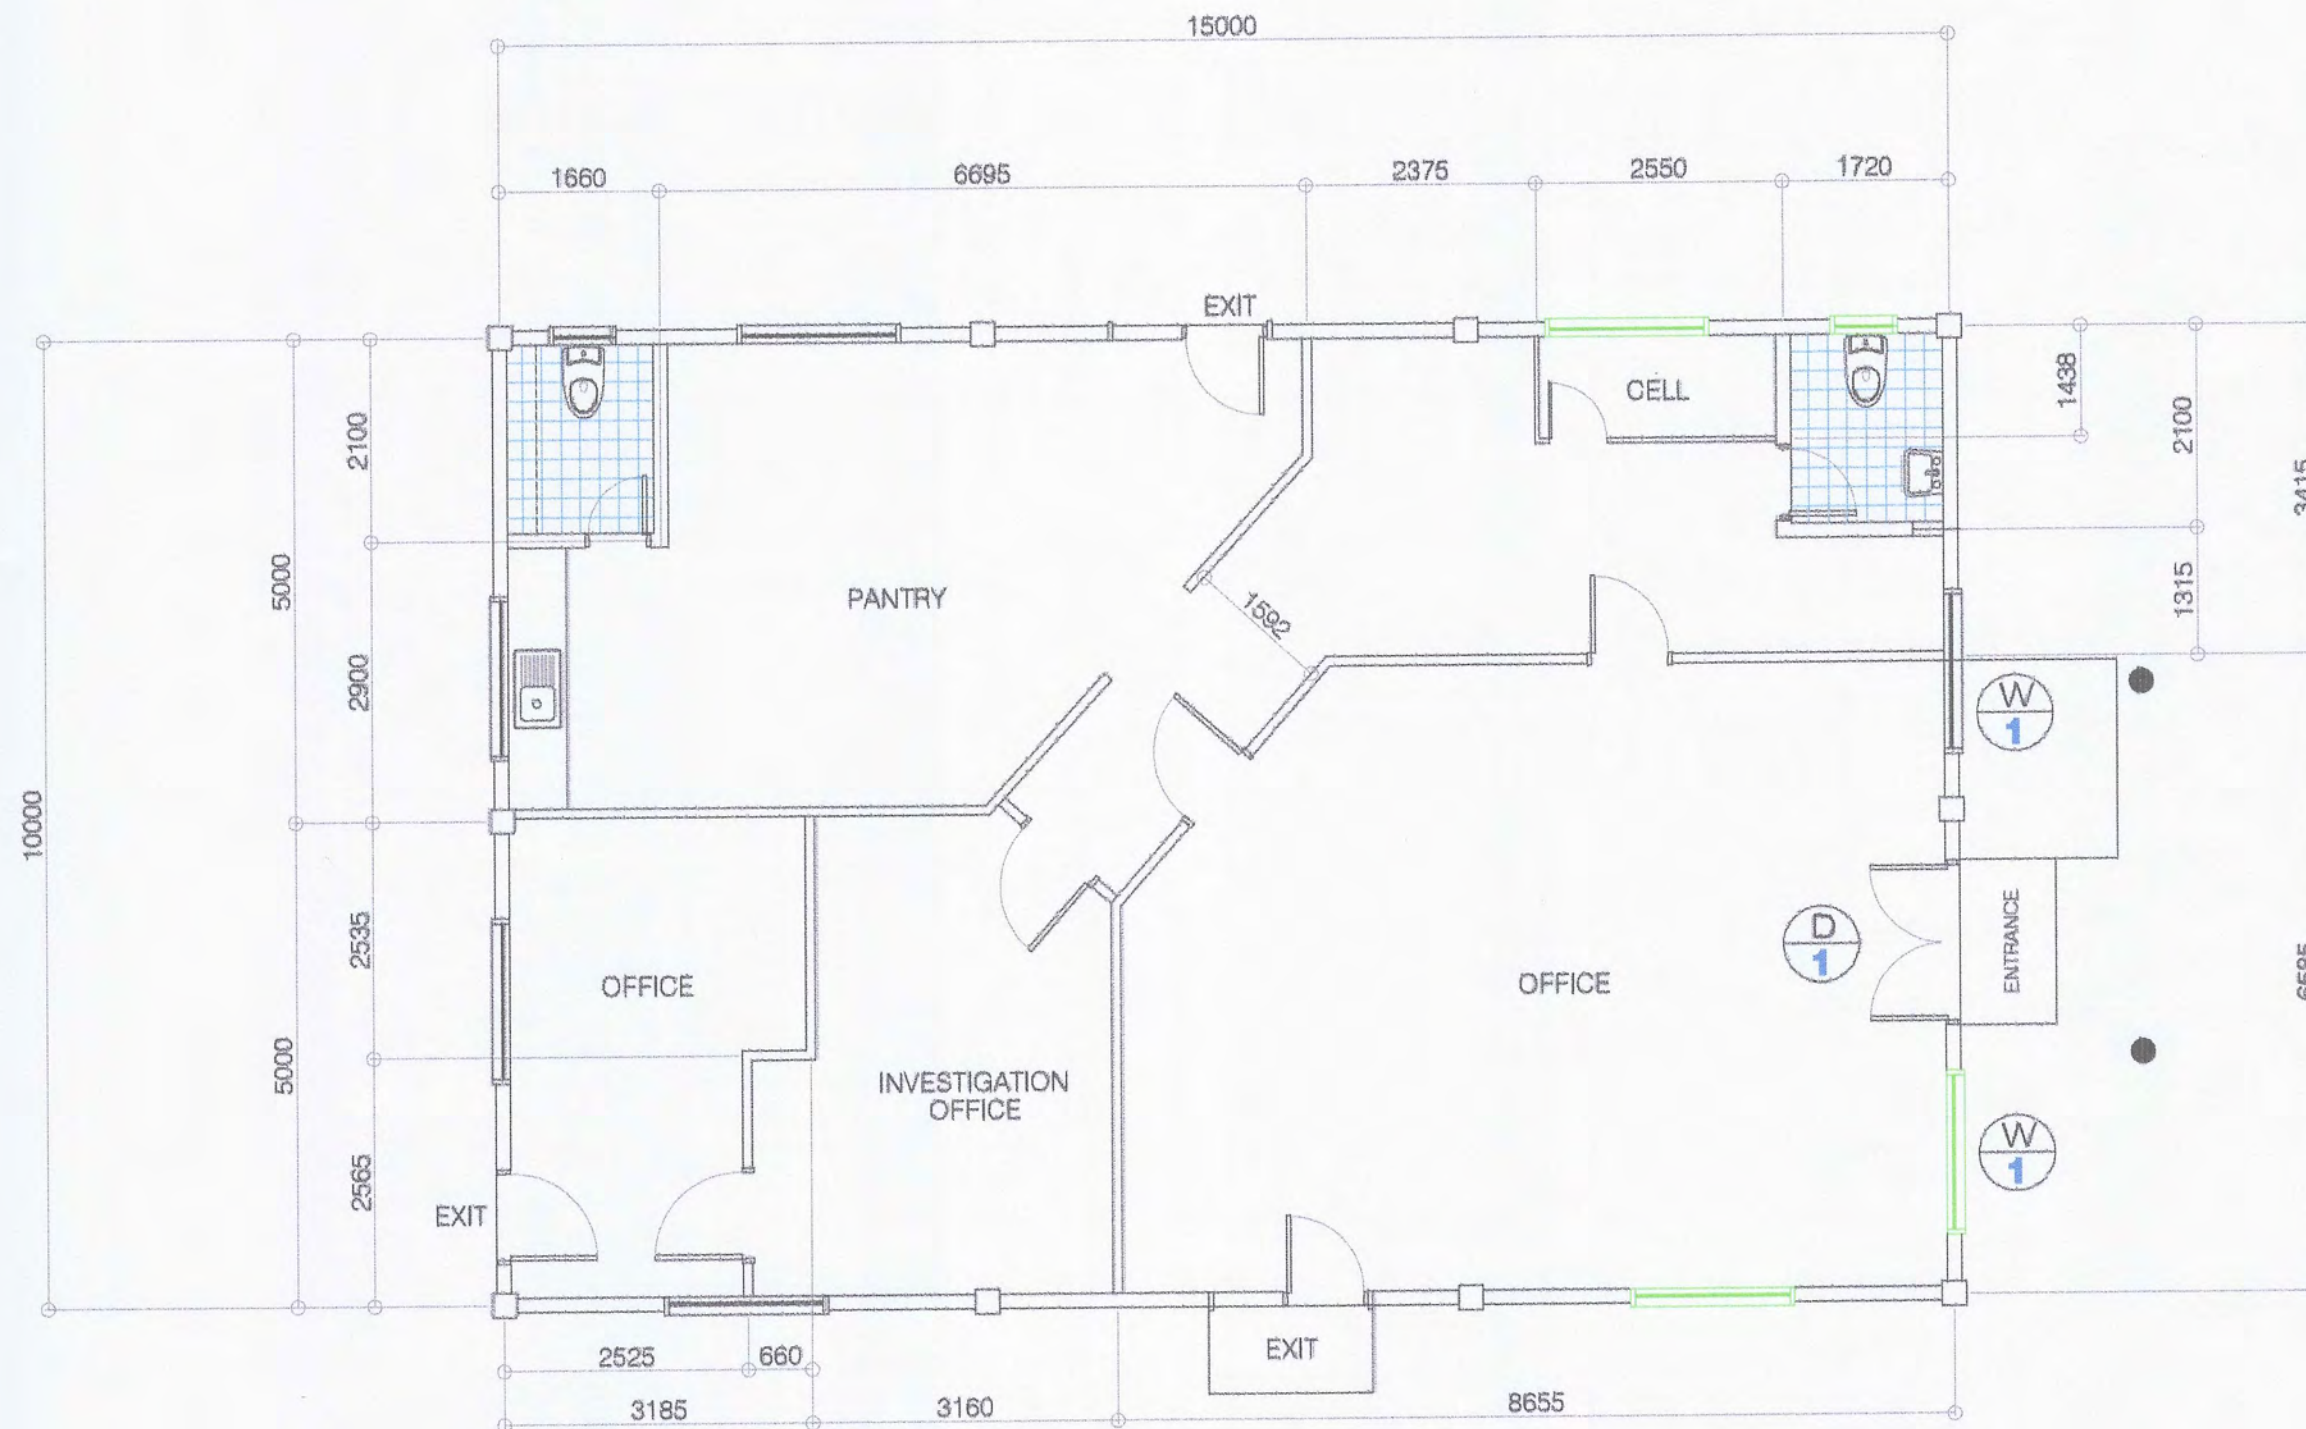

EXISTING FLOOR PLAN OF PORT POLICE DIVISION

SCALE:

1:80



PORT OF
CAGAYAN DE ORO
MISAMIS ORIENTAL

TITLE:

REPAIR OF PORT POLICE OFFICE

LOCATION:

PORT OF CAGAYAN DE ORO

PREPARED BY:

KAREL T. SOMICAD
Construction Foreman

CHECKED BY & SUBMITTED BY:

MARC M. AVELLANA
Supervising Engineer A

RECOMMENDED BY:

ANTONIO M. TORCINO, JR.
Acting ESD Manager

APPROVED:

FERNANDO B. MAPALO, JR.
Acting Port Manager


ARCHITECTURAL

SHEET CONTENTS

EXISTING FLOOR PLAN OF
PORT POLICE DIVISION

SHEET NO.

2
5

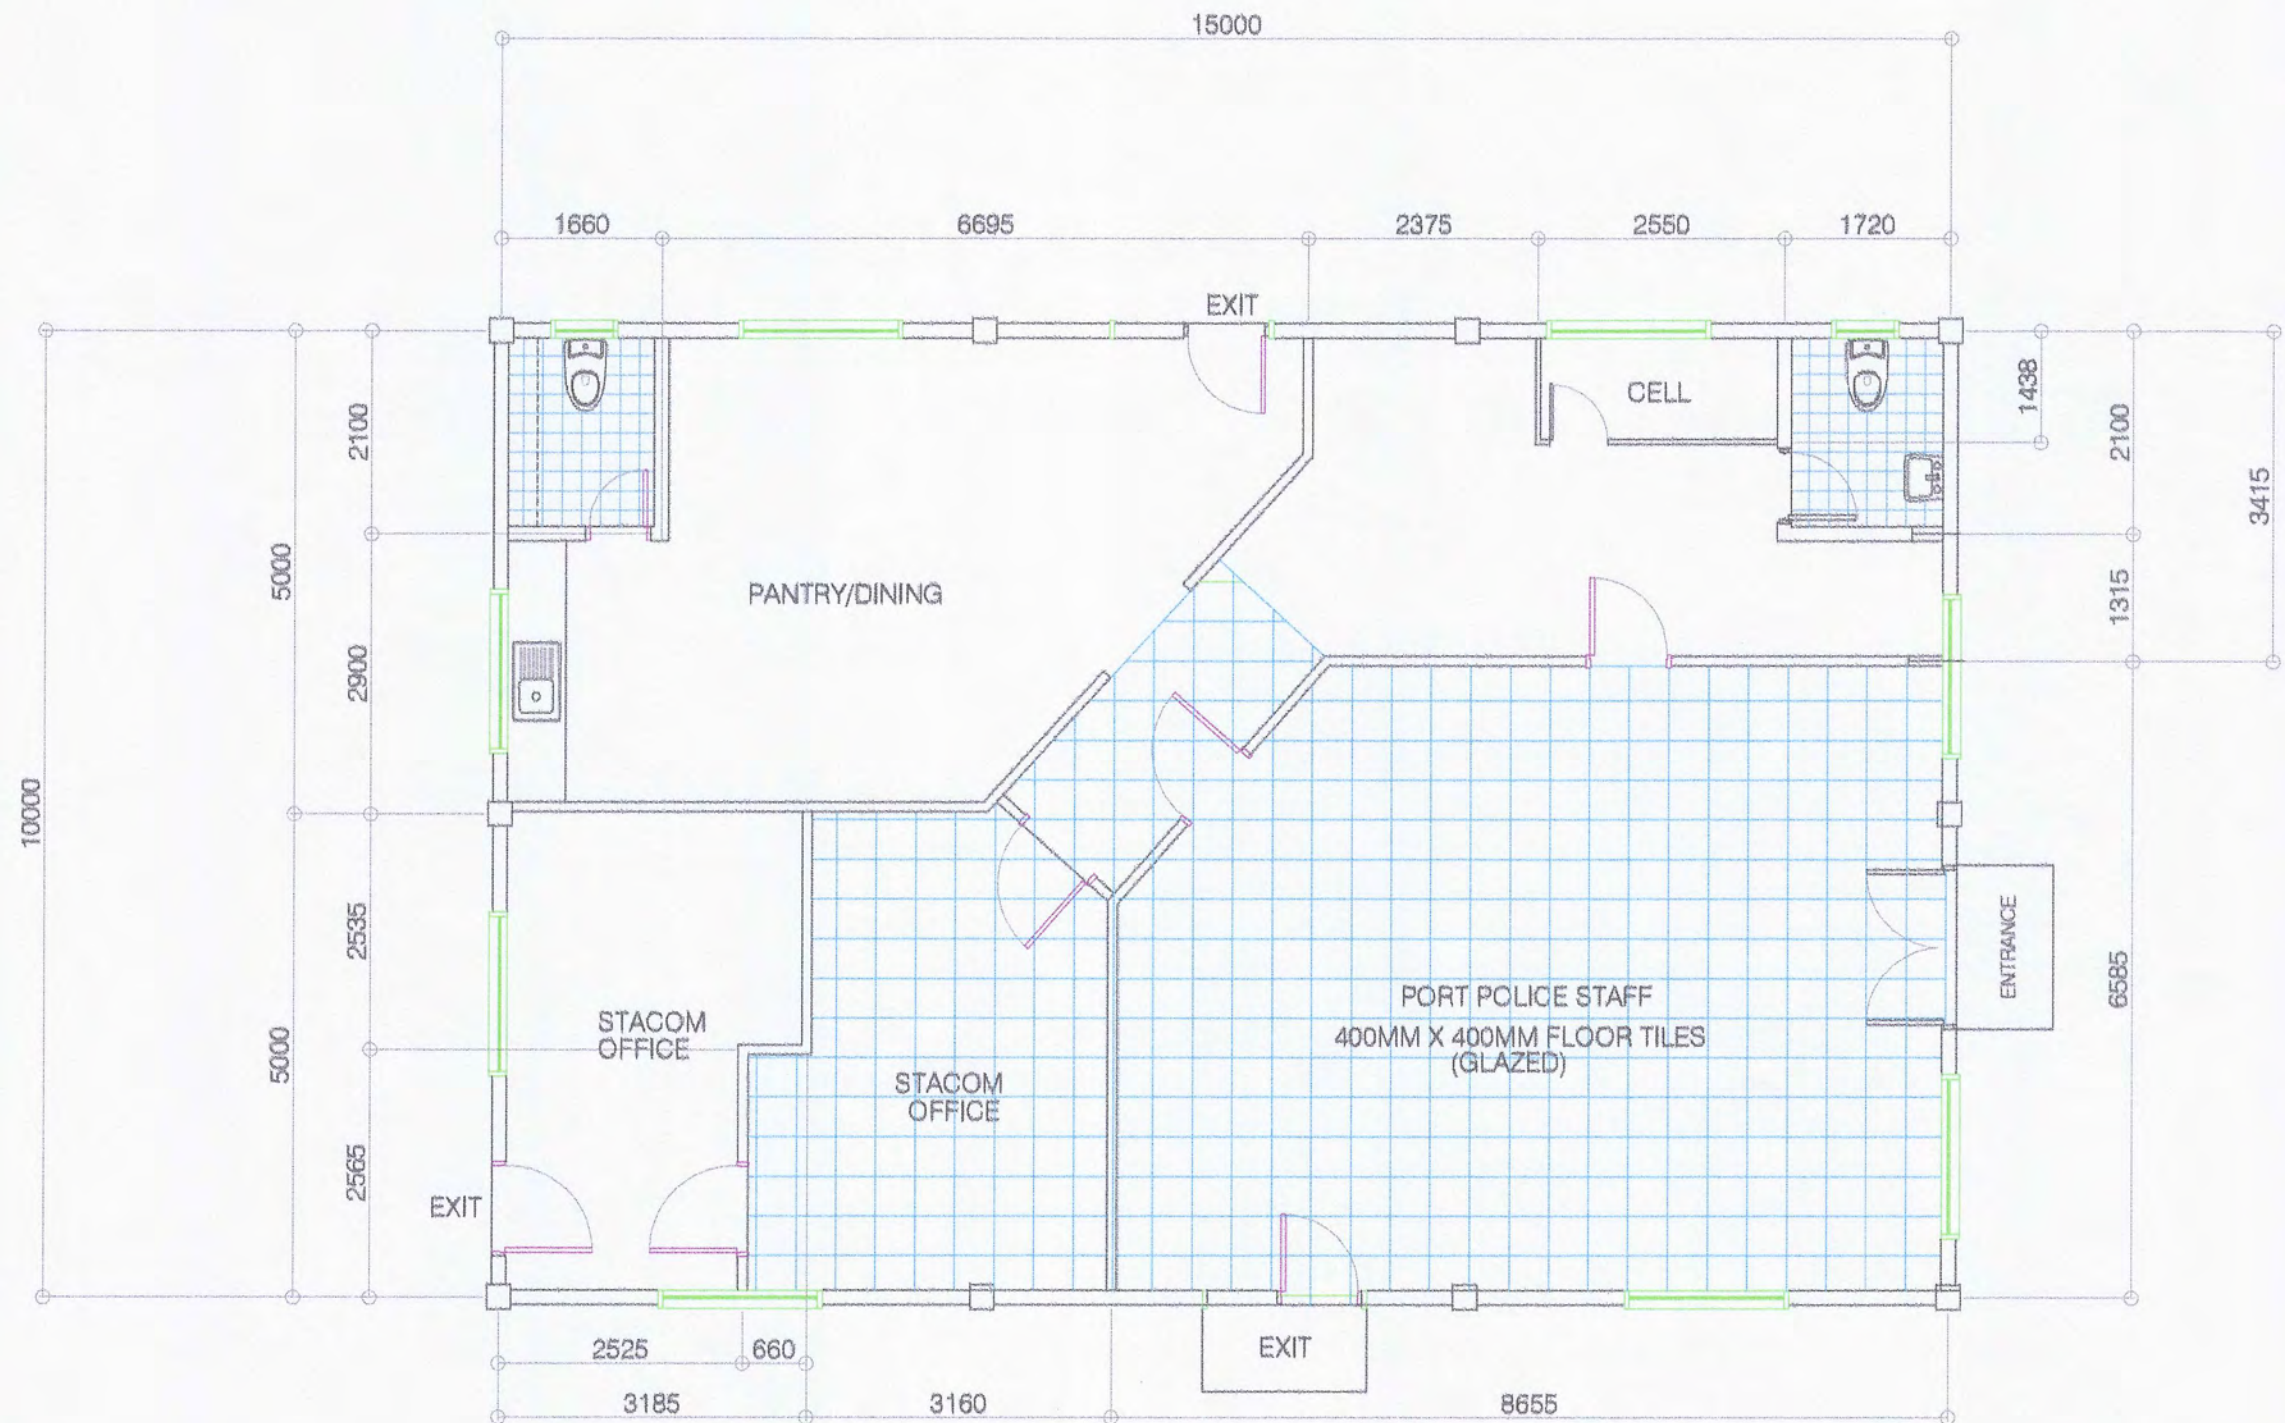

FLOOR TILE PLAN

SCALE: 1:80



PORT OF
CAGAYAN DE ORO
MISAMIS ORIENTAL

TITLE:

REPAIR OF PORT POLICE OFFICE

LOCATION:

PORT OF CAGAYAN DE ORO

PREPARED BY:

KAREL T. SUMICAD
Construction Foreman

CHECKED BY & SUBMITTED BY:

MARC M. AVELLANA
Supervising Engineer A

RECOMMENDED BY:

ANTONIO M. TORCINO, JR.
Acting ESD Manager

APPROVED:

FERNANDO B. MADALO, JR.
Acting Port Manager


ARCHITECTURAL

SHEET CONTENTS


FLOOR TILE PLAN

SHEET NO.


3
5

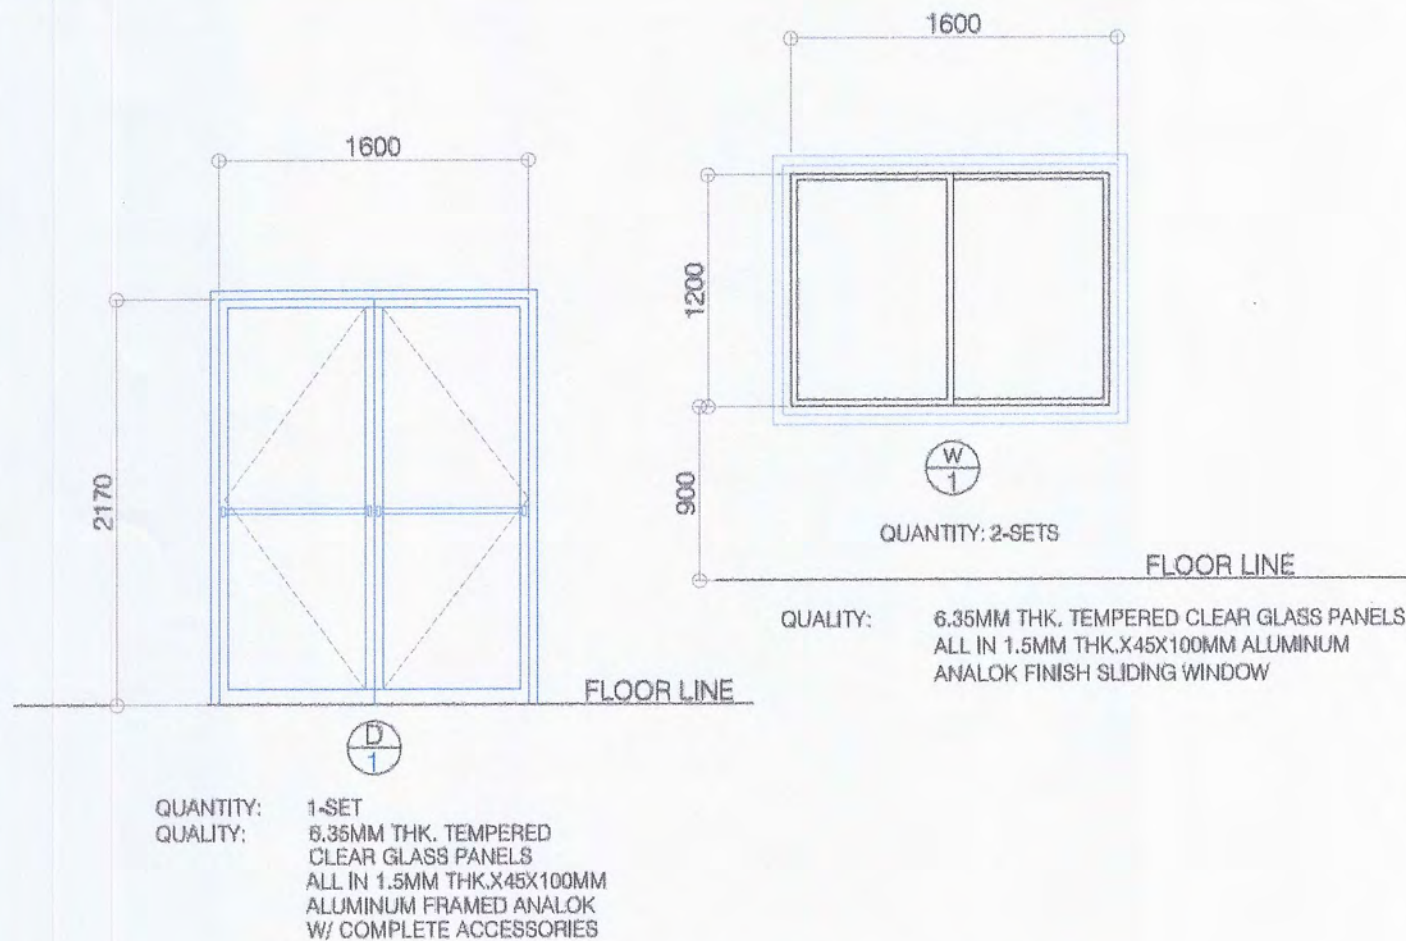

DETAIL OF DOORS & WINDOWS
 SCALE: 1:40

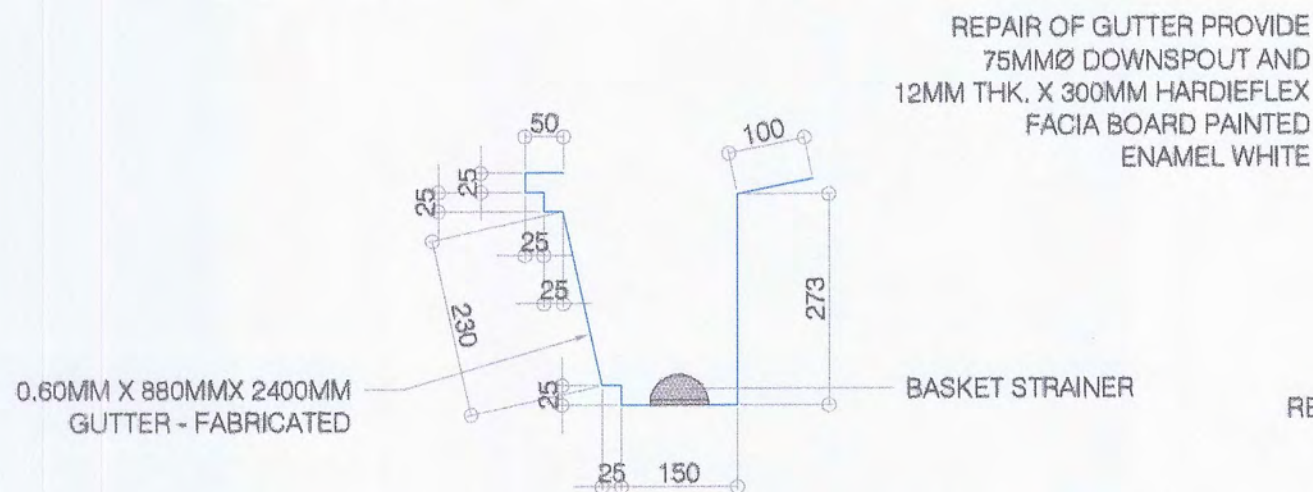

DETAIL OF GUTTER
 SCALE: 1:10

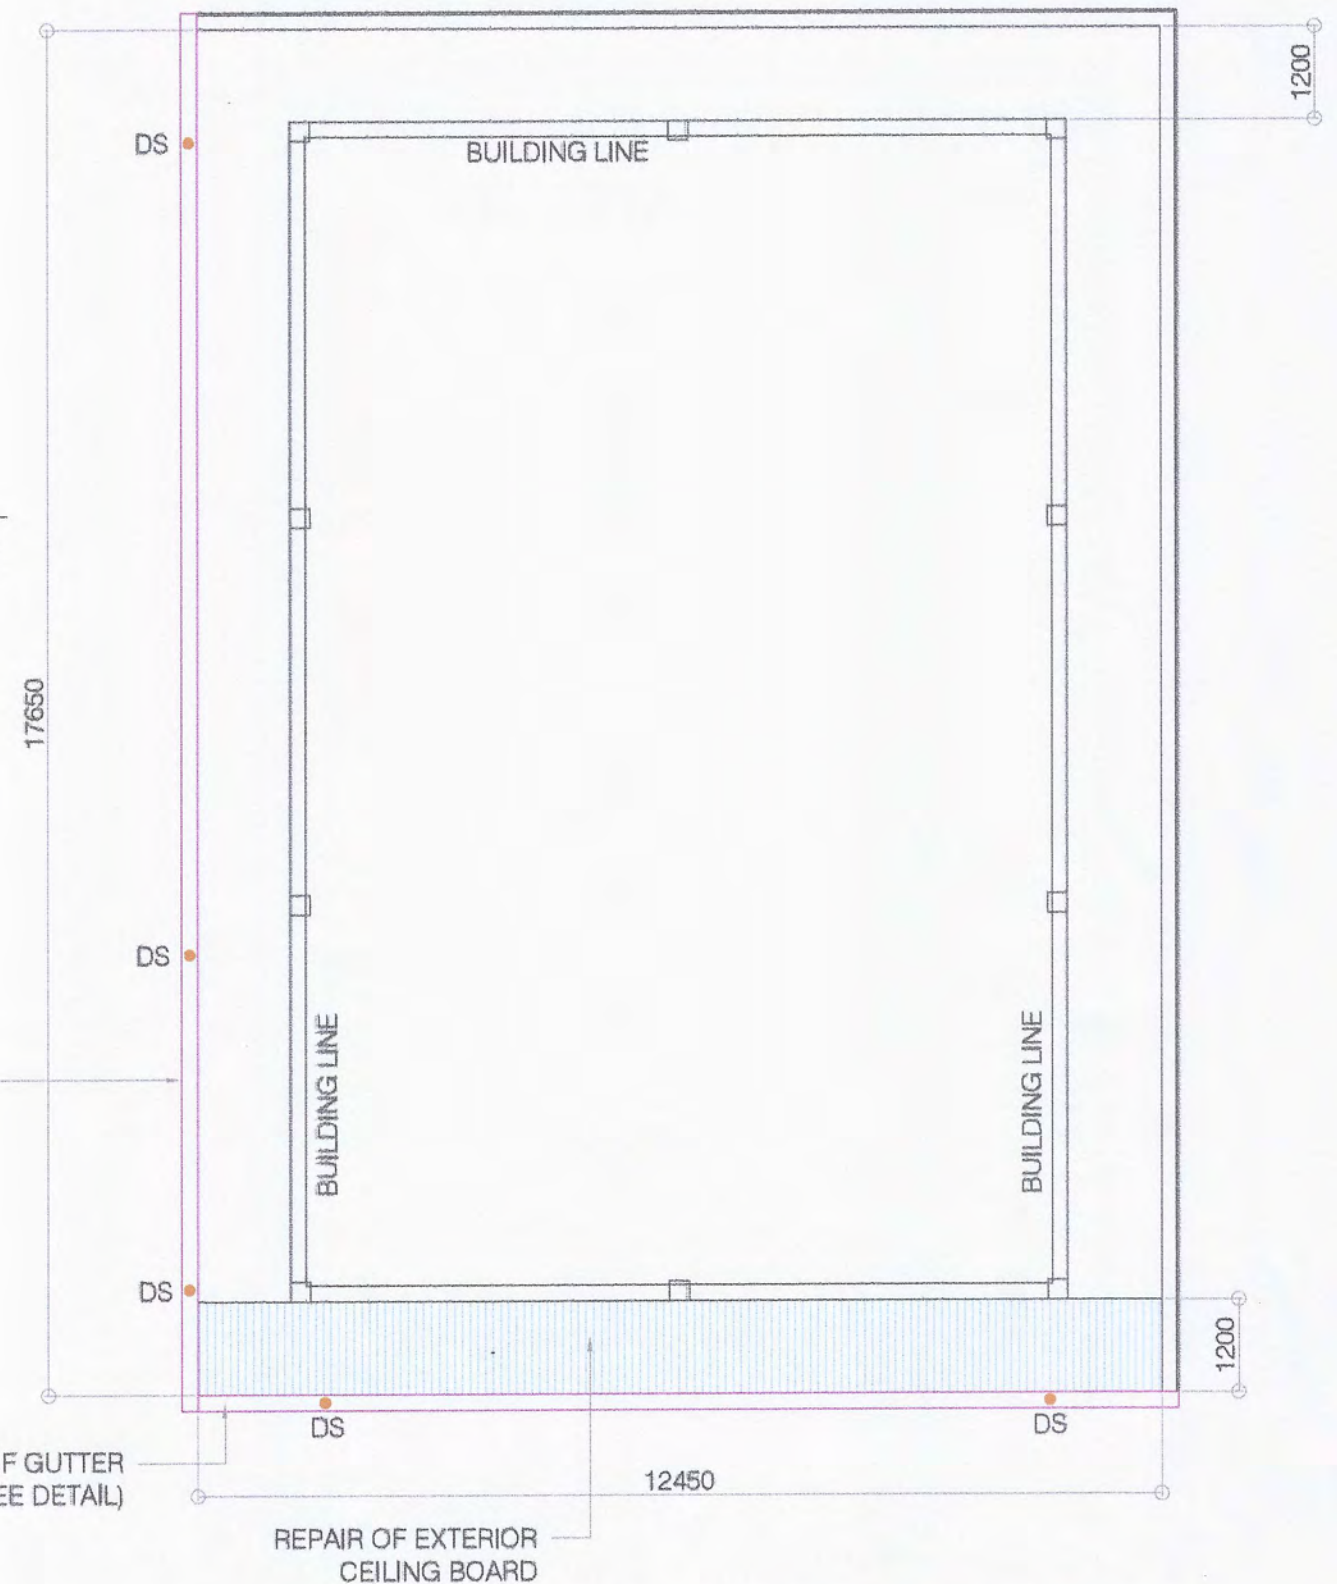

REPAIR OF EXTERIOR CEILING BOARD
 SCALE: 1:100



PORT OF
 CAGAYAN DE ORO
 MISAMIS ORIENTAL

TITLE:

REPAIR OF PORT POLICE OFFICE

LOCATION:

PORT OF CAGAYAN DE ORO

PREPARED BY:

KAREL T. SOMICAD
 Construction Foreman

CHECKED BY & SUBMITTED BY:

MARC M. AVELLANA
 Supervising Engineer A

RECOMMENDED BY:

ANTONIO M. TORCINO, JR.
 Acting ESD Manager

APPROVED:

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 Acting Port Manager


ARCHITECTURAL

SHEET CONTENTS

DETAIL OF GUTTER
 REPAIR OF EXTERIOR CEILING BOARD
 DETAIL OF DOORS & WINDOWS

SHEET NO.

4
 5

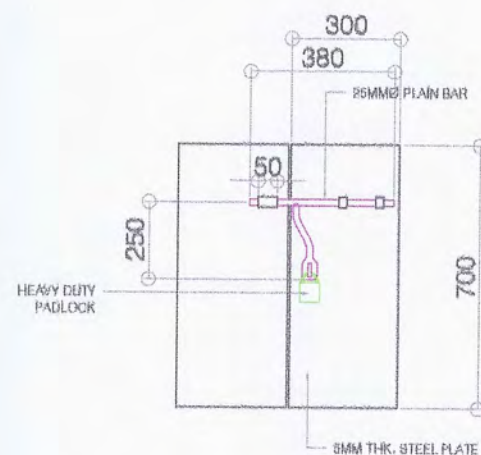

16MM DEF BARS @100MM SPACED
ON CENTER, APPLY ENAMEL WHITE

6MM THK.
STEEL PLATE

BARREL BOLT

700
CELL DOOR

10MM THK. X 38MM FLAT
BAR FRAME

16MM DEF BARS
@100MM SPACED
ON CENTER

16MMØ HOR.
BARS

DETAIL OF BARREL BOLT

SCALE:

1:20

PLAN OF DETENTION CELL DOOR

SCALE:

1:40

12MMØ CEILING STEEL BAR
@ 100MM ON CENTER, APPLY
ENAMEL WHITE

DETENTION CELL

PLAN OF DETENTION CELL

SCALE:

1:40

DETENTION CELL CEILING

SCALE:

1:40



PORT OF
CAGAYAN DE ORO
MISAMIS ORIENTAL

TITLE:

REPAIR OF PORT POLICE OFFICE

LOCATION:

PORT OF CAGAYAN DE ORO

PREPARED BY:

KAREL T. SUMICAD
Construction Foreman

CHECKED BY & SUBMITTED BY:

MARC M. AVELLANA
Supervising Engineer A

RECOMMENDED BY:

ANTONIO M. TORCINO, JR.
Acting ESD Manager

APPROVED:

FERNANDO B. MAPALO, JR.
Acting Port Manager

ARCHITECTURAL

SHEET CONTENTS

PLAN OF DETENTION CELL
DETAIL OF BARREL BOLT
DETENTION CELL CEILING
PLAN OF DETENTION CELL DOOR

SHEET NO.

5
5